
project synopsis: architecture&engineering Governing Municipality: Independence, Missouri 4301 Indian Creek Parkway Overland Park, KS 66207 phone: 913,451,9390 Governing Code: 2018 International Building Code Karsten W. Erdman fex: 913.451.9391 Project Manager / Davidson Architecture & Engineering www.davidsonae.com Point of Contact: 4301 Indian Creek Parkway Overland Park, Kansas 66207 p: 913.451.9390 Owner: McBee Coffe N' Carwash, Inc. 103 Industrial Parkway Gallatin, MO 64640 Civil Engineer: Hilary Zerr, PE Davidson Architecture & Engineering 4301 Indian Creek Parkway Overland Park, Kansas 66207 p: 913.451.9390 SANITARY MANHOLE -Site Area: 66,032 ± sq. ft., 1.51 ± acres TOP ELEV. = 764.548" PVC INV. IN ₹=754.6 6,503 sq. ft. Building Area: BP / PUD Zoning: Proposed Imperv. Area: 39,593 ± sq. ft. (0.908 acres) 60.00% Proposed Green Space: 26,439 ± sq. ft. (0.607 acres) 40.00% 19 standard vacuum bays 1 handicap vacuum bay 6 standard employee spaces ∕ Ex. 1/2" Rebar 1 handicap employee space Total = 27 spaces provided & Plastic Cap MMI MO LS 1999141096 general notes: LOT 2 • All construction shall conform to the standards and specifications of Independence, Missouri. • The general contractor shall contact all utility companies prior to the start of construction and verify the location and depth of any utilities that may be encountered during construction. Owner: Owner: • The contractor shall field verify exist. surface & subsurface ground conditions prior to start of DTP Oconee Properties LLC Menard Inc. construction. • Slopes shall maintain a maximum 3:1 slope. • The contractor shall be responsible for obtaining all required permits, paying all fees, and otherwise Address: Address: complying with all applicable regulations governing the project. 4111 S. Little Blue Parkway 4101 S. Little Blue Parkway General contractor and all subcontractors must register with the Building Department before • Energy code requirements and inspections are to be performed by a third party inspector, supplied by General Contractor and/or owner. The City will not perform energy related inspections, however, documentation is required to verify compliance of the energy code requirements. CURB INLET • Place silt fence per civil for erosion control. TOP ELEV. =762.63 Provide a temporary gravel access drive to prevent mud from being deposited onto the adjacent 36" PVC = 757.71 • Prior to installing any structure on a public storm sewer, the contractor shall submit shop drawings for the structure(s). Installation shall not occur until drawings have been approved by public works. Prior to installing, constructing, or performing any work on the public storm sewer line (including) connecting private drainage to the storm system) contact the city for inspection of the work. Contact must be made at least 48 hours prior to the start of work. • Connections to the public storm sewer between structures will not be permitted. • All exterior utility services shall be painted to match the primary building color. • Prior to final inspection, the general contractor shall meet with the Independence Fire Department to designate fire lane and fire lane sign locations to be installed per Fire Department direction and • A Knox Box will be installed on the front of the building facing the street or road. • Caulk joint at perimeter of building around sidewalk. Color to match building colors. GC shall take care not to seal any exterior finish drainage elements. construction notes: 1. Monument sign per detail 2/A3.2. Footing by GC and sign by signage supplier. GC shall install electrical per electrical drawings. 2. Pay station equipment by others. Footings by GC and equipment by supplier. GC shall install electrical per electrical drawings and footings per equipment vendor drawings. 79 TH STREET 3. Trash enclosure per detail 1/A1.2. 4. Directional sign (THANK YOU / DO NOT ENTER) per detail 1/A3.2. SANITARY MANHOLE -5. Directional sign (WELCOME) per detail 1/A3.2. TOP ELEV. =761.88 6. ADA parking stall per civil drawings. date 4" solid white striping typ. 8" PVC INV OUT = 758.4 07.14.2022 8. Light pole and base per electrical drawings - GC shall install Owner furnished drawn by corrugated metal pipe as form for exposed 36" concrete base above finish grade and protect during construction. DAE 9. White thermoplastic directional markings per detail. checked by 10. Furnish and install concrete curb and gutter per civil drawings. DAE 11. Concrete paving to meet Geotechnical specifications and per civil drawings. 12. Asphalt paving to meet Geotechnical specifications and per civil drawings. revisions 13. New concrete sidewalk per civil. 14. Snow melt system at carwash entry and exit per plumbing drawings. PSF TMC DB Independence LLC 15. Handicap parking sign per detail on A1.3. 16. Accessible ramp at sidewalk per civil. Address: 17. Furnish and install a Knox Box at 60" a.f.g. for fire department access. Contact Fire 4131 S. Little Blue Parkway Marshal for ordering information and to coordinate location prior to installation. 18. Downspout to tie into storm system per civil drawings. 19. Furnish and install mechanical screen per details on sheet A1.2. 20. Vacuum canopy above per vacuum equipment supplier - Vac column piers shall be poured at a consistent elevation. Refer to equipment drawings for specific requirements. 21. Approximate transformer location per electrical drawings. 22. Vacuum turbine enclosure per detail 5/A1.2. Ex. 1/2" Rebar -& Plastic Cap 23. 15' front building setback line. 24. Furnish and install 30' flag pole with direct ground mounted up-light per electrical MMI MO LS drawings - footing design by structural. 1999141096 23. Furnish and install 5' concrete public sidewalk per civil drawings. 24. Concrete flume per civil drawings. 25. Approximate location of electrical transformer per electrical drawings. sheet number 26. Proposed underground detention area per civil to tie into existing curb inlet on Little Blue Parkway. drawing type PDP/SUP project number

21072-17

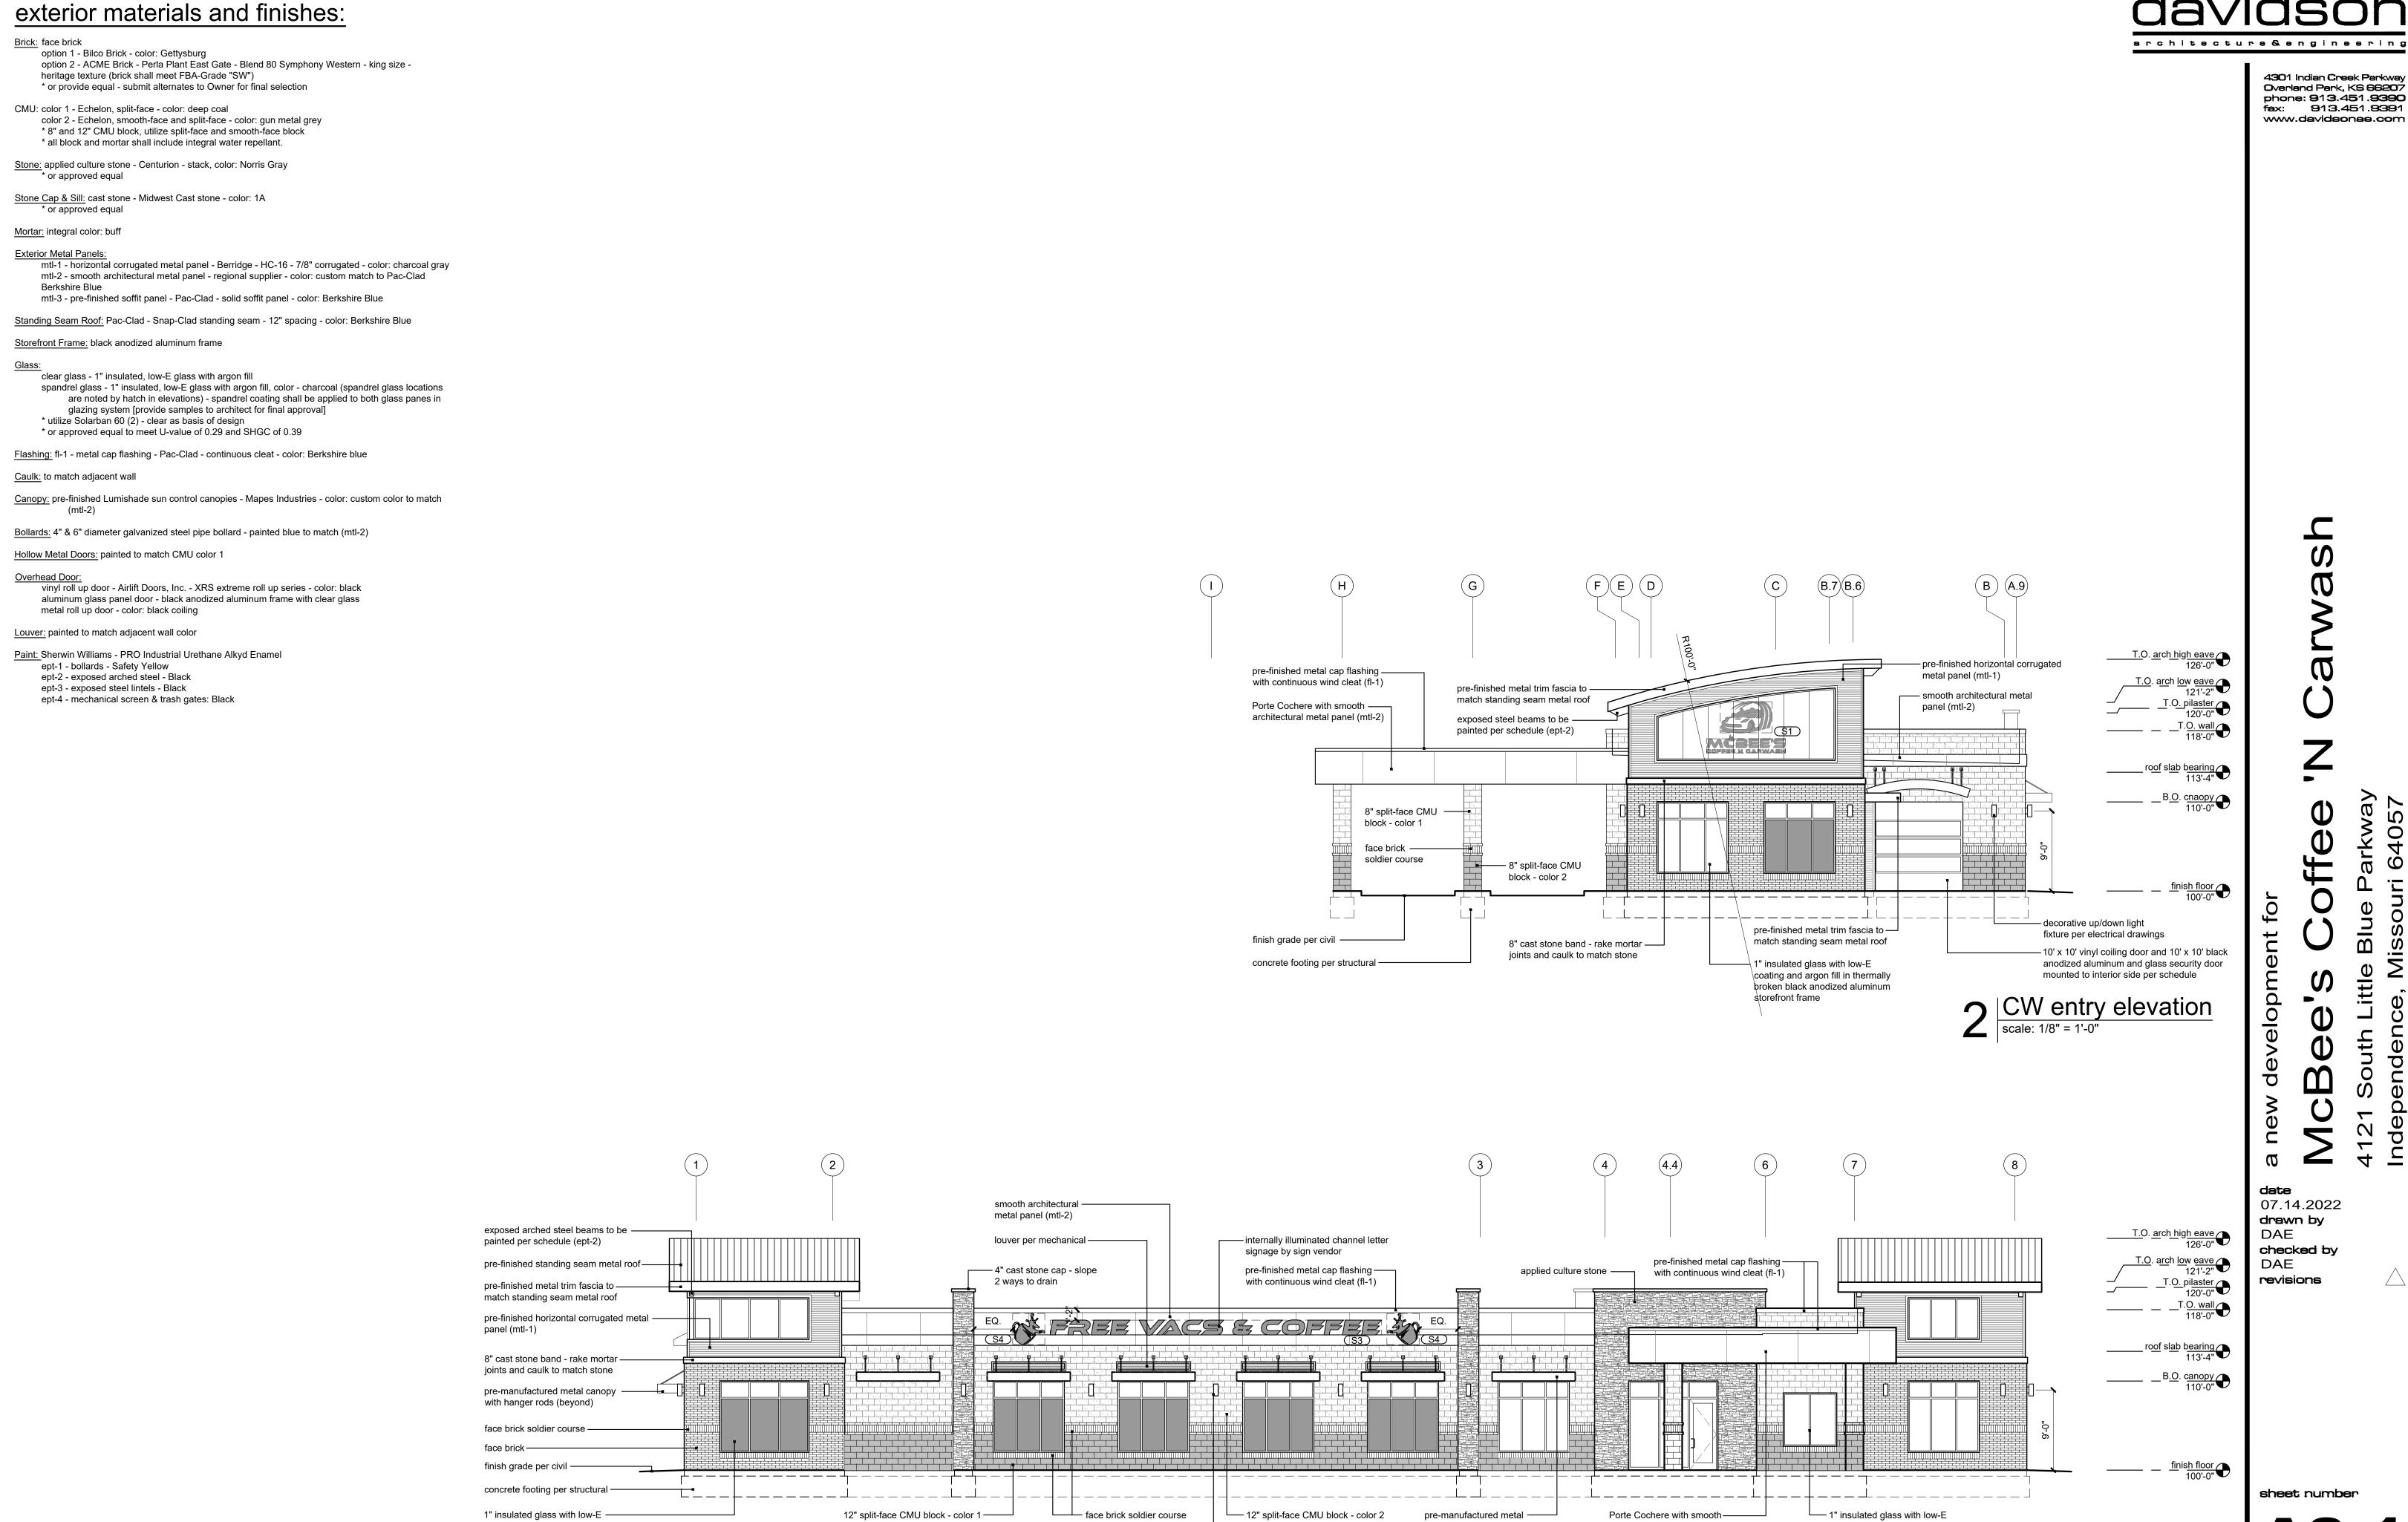

coating and argon fill in thermally

broken black anodized aluminum

storefront frame (utilize spandrel

glass at hatched areas)

4301 Indian Creek Parkway Overland Park, KS 66207 phone: 913.451.9390 fex: 913.451.9391 www.davidsonae.com

07.14.2022 drawn by checked by

sheet number

drawing type PDP/SUP

project number

21072-17

coating and argon fill in thermally

broken black anodized aluminum

storefront frame (utilize spandrel

front elevation
scale: 1/8" = 1'-0"


glass at hatched areas)

canopy with hanger rods

decorative up/down light

fixture per electrical drawings

architectural metal panel (mtl-2)

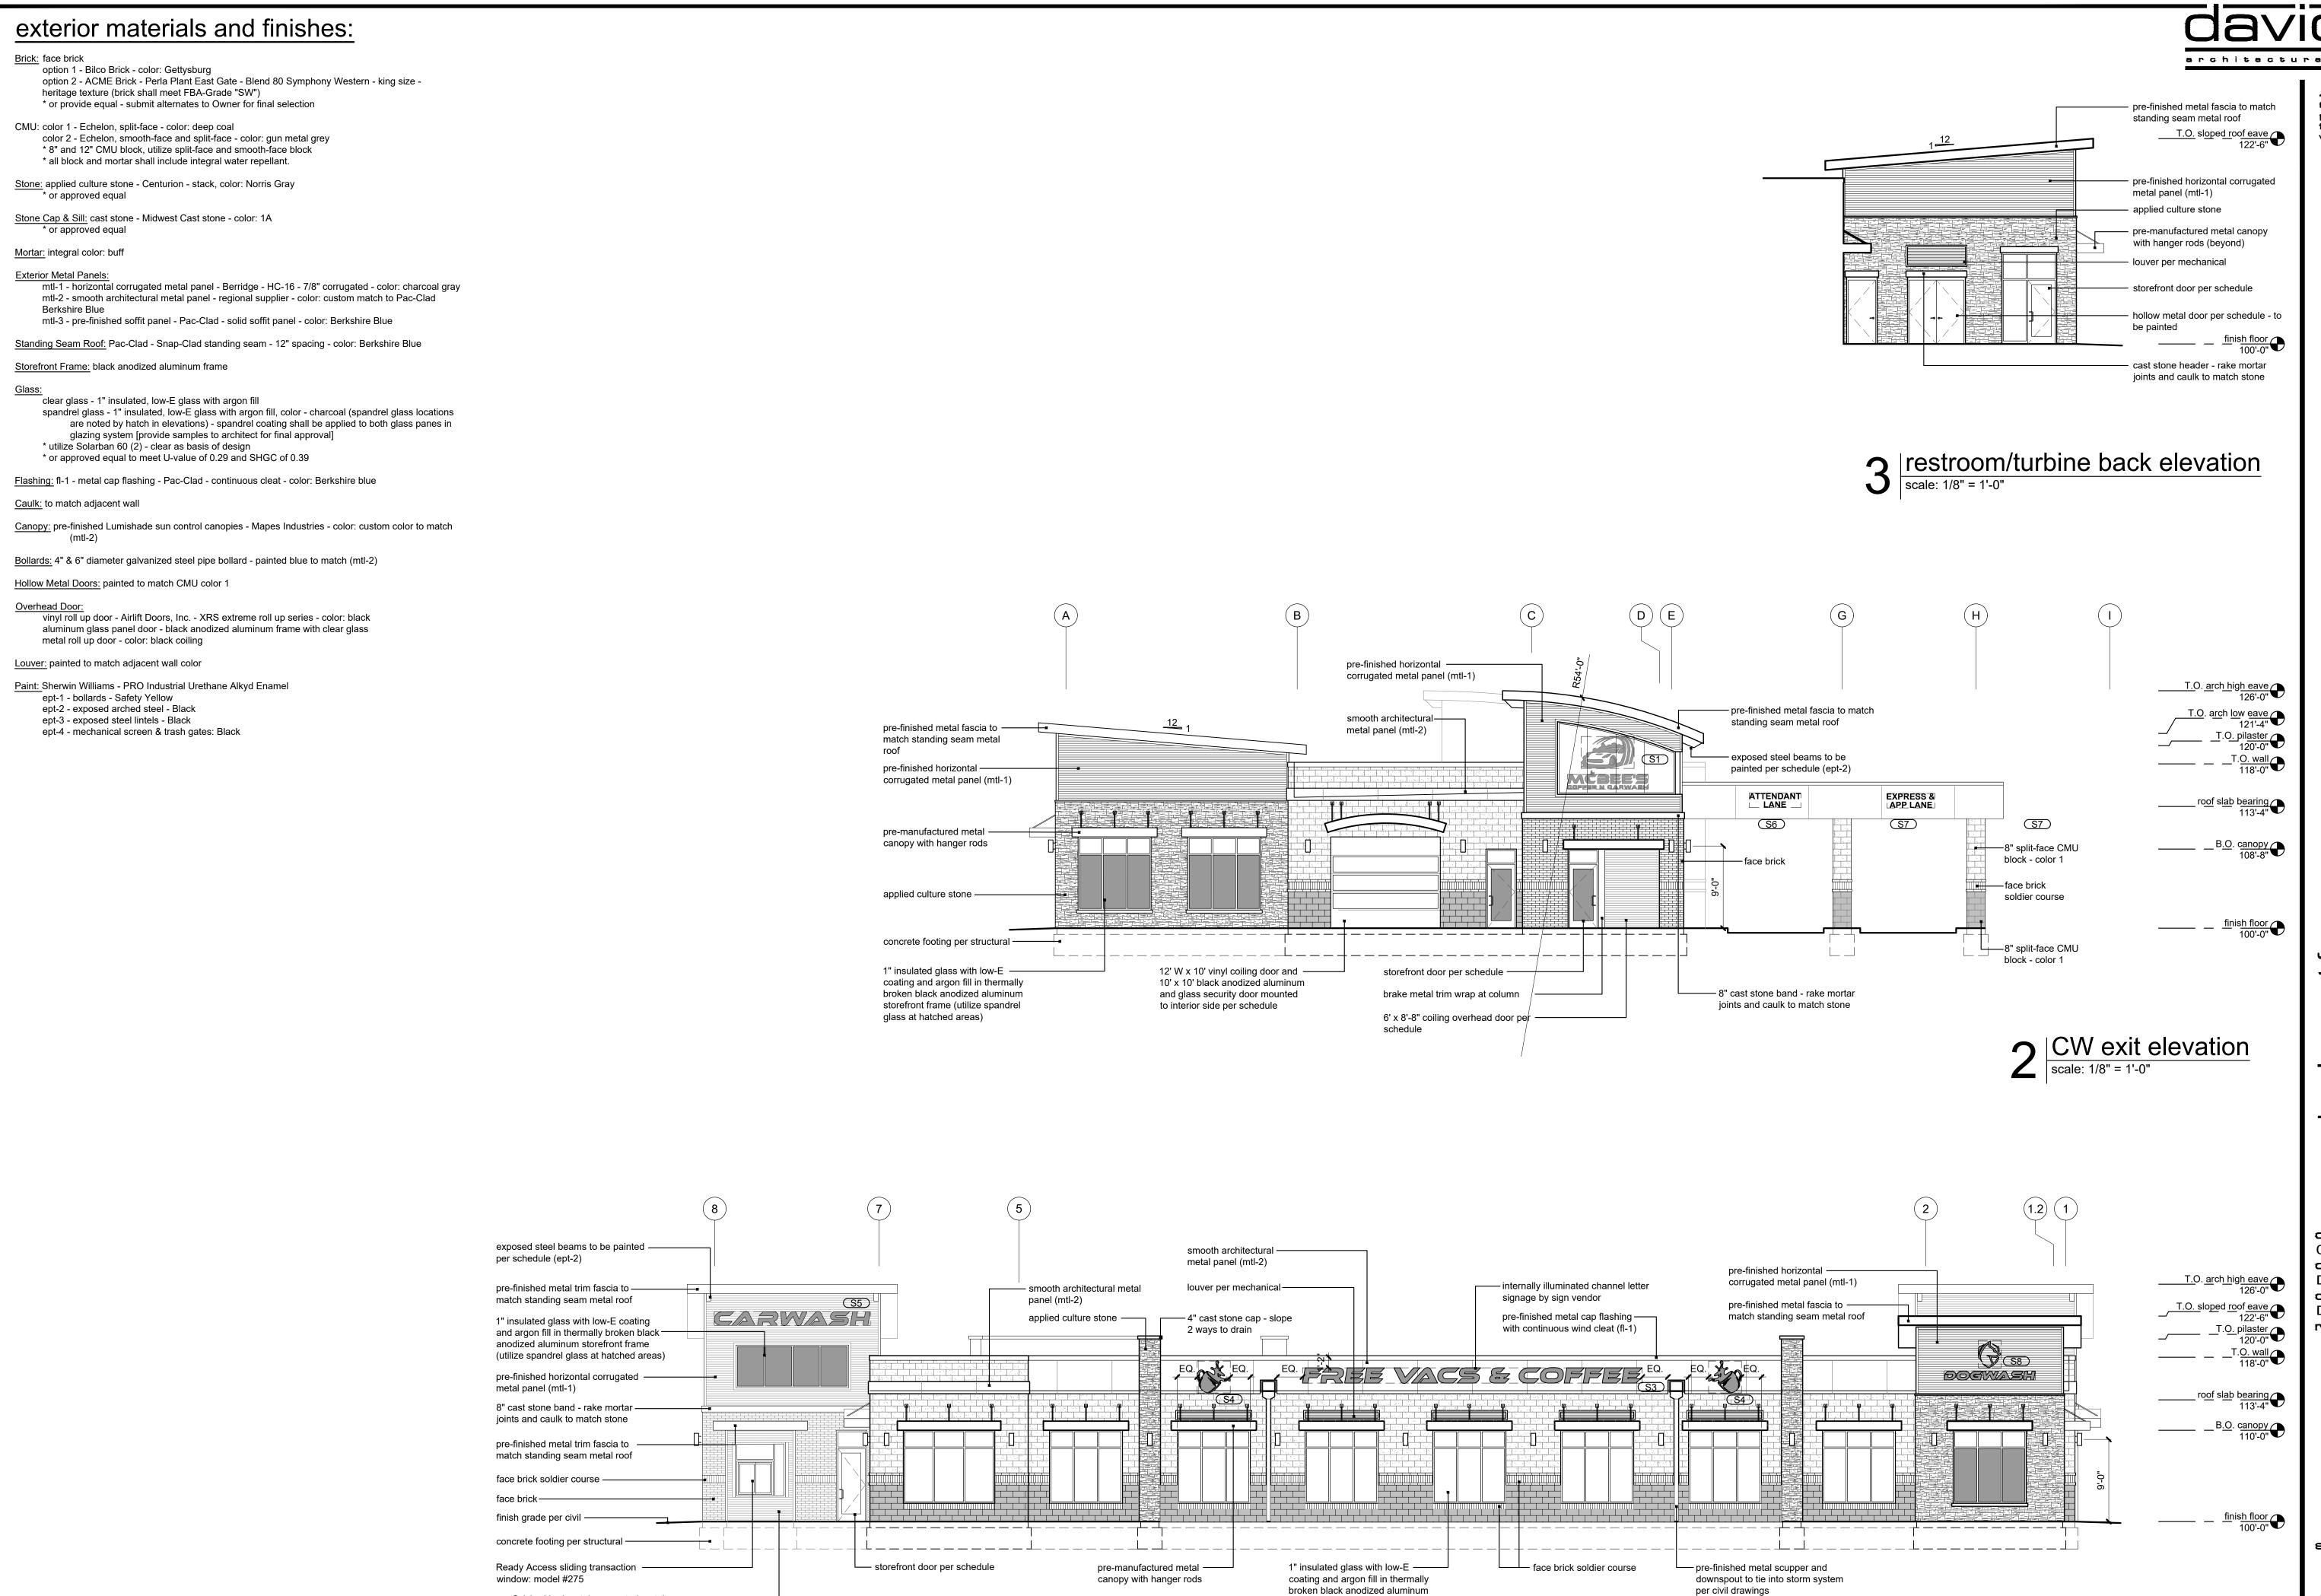

storefront frame (utilize spandrel

glass at hatched areas)

pre-finished horizontal corrugated metal -

panel (mtl-1)

architecture & engineering
4301 Indian Creek Parkway

4301 Indian Creek Parkway Overland Park, KS 66207 phone: 913.451.9390 fax: 913.451.9391 www.davidsonae.com

s's Coffee 'N Carv

a new development for McBee's Coff

date
00.00.2022
drawn by
DAE
checked by
DAE
revisions

sheet number

A3.2

drewing type
PDP/SUP
project number
21072-17

back elevation scale: 1/8" = 1'-0"

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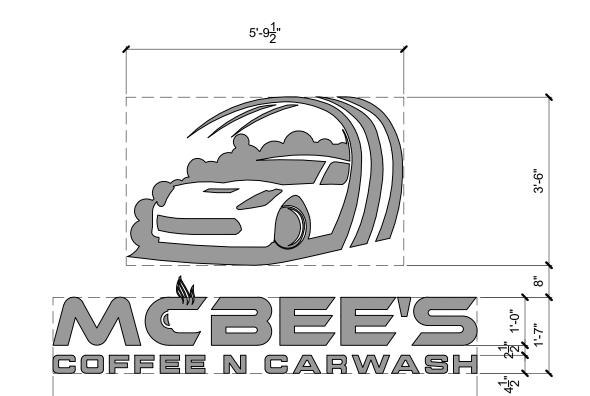
Sign Specifications:

- 1. Building signs: provide conduit and wire from electrical panel to the sign. The conduit is to be 1" and have one set of 10/2 wire with
- 2. Final electrical connections for sign shall be the sign vendors responsibility since the "J" box and wires are in place.
- 3. Pylon / monument signs: provide conduit from electrical panel to location of the pylon / monument sign base bury conduit under parking area. The conduit is to be 1" and have one set of 10/2 wire with ground.
- 4. Provide maximum allowable signage by the AHJ.

	Signage Coverage					
elevation	elevation sqft.	signage sqft.	coverage %			
front	3,117	87.2	2.79%			
CW entry	1,290	34.2	2.65%			
CW exit	1,723	59.8	3.47%			
back	2,969	130.3	4.38%			

Building Signage (internally lit) ##						
sign	overall size	sign sqft.				
main logo w/ tagline (S1)	8'-10" X 5'-9"	34.2				
McBee Coffee N' Carwash (S2)	8'-10" X 1'-7"	14				
free vacs & coffee (S3)	37'-2 1/2" X 1'-8"	62				
coffee cup (S4)	3'-7 1/4" X 3'-6"	12.6				
carwash (S5)	17'-1" X 1'-6"	25.6				
dogwash sign (S8)	10'-0" X 4'-4"	17.5				
monument sign	7'-8" x 4'-4"	30 / side				
directional sign	2'-0" X 1'-0"	2				
Building Signage (non-illuminated) #						
sign	overall size	sign sqft.				
D-T attendant lane (S6)	5'-8" X 1'-7"	9				

D-T express / app lane (S7)




5'-3" X 1'-7"

8.3


S1: main logo with tagline - internally lit sign scale: 1/2" = 1'-0"




S2: McBee Coffee N' Carwash - internally lit sign scale: 1/2" = 1'-0"

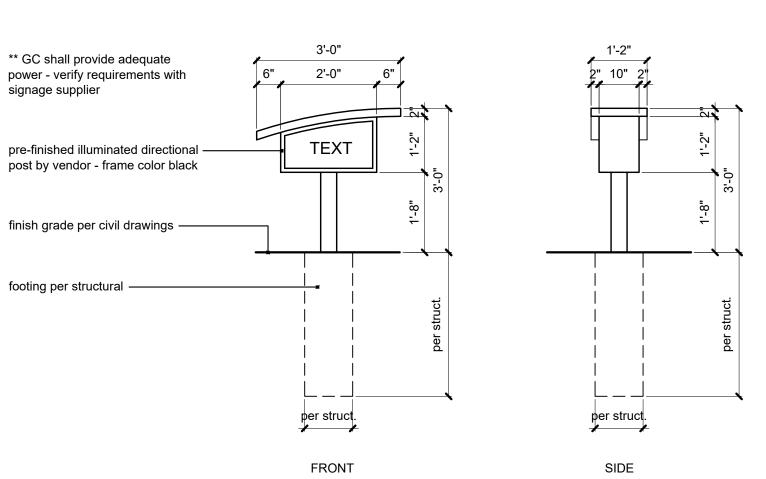


directional sign
| scale: 1/2" = 1'-0"

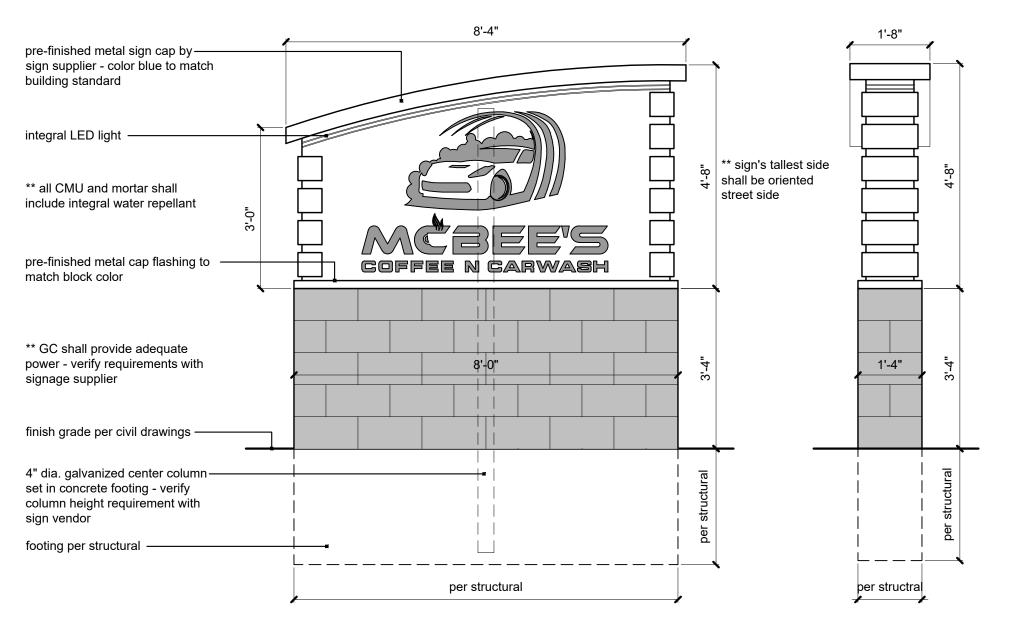


3 monument sign elevation scale: 1/2" = 1'-0"

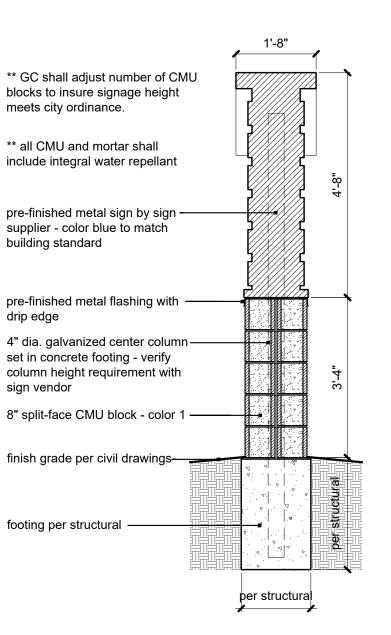

2 monument sign section scale: 1/2" = 1'-0"

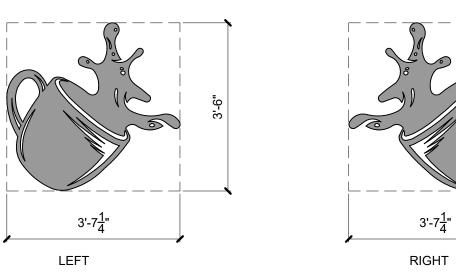


S4: Coffee Cup logo - internally lit sign scale: 1/2" = 1'-0"

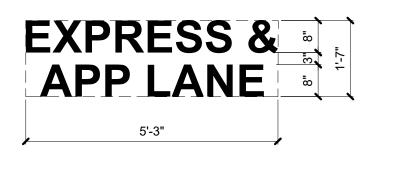


S7: DT Carwash / App sign scale: 1/2" = 1'-0"




S6: D-T CNC sign scale: 1/2" = 1'-0"

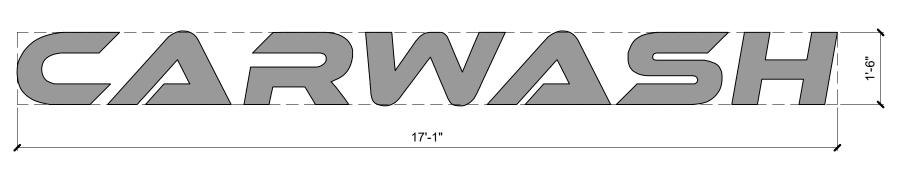

S5: Carwash logo - internally lit sign scale: 1/2" = 1'-0"

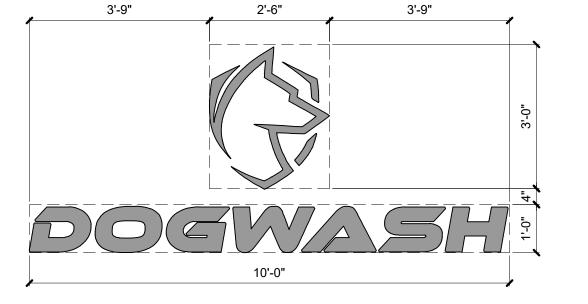

S8: dogwash sign - internally lit scale: 1/2" = 1'-0"

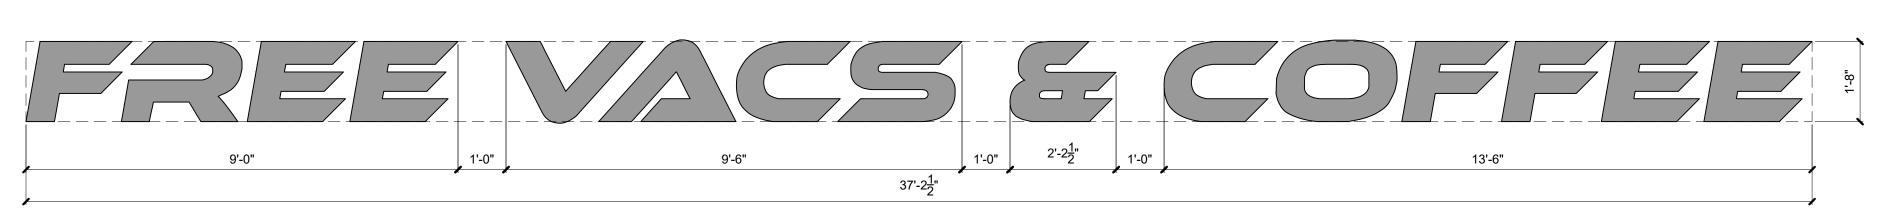

S3: McBee Coffee N' Carwash - internally lit sign scale: 1/2" = 1'-0"

sheet number

A3.3

drawn by DAE

revisions

DAE

checked by

drawing type PDP/SUP project number 21072-17

date 00.00.2022



	Tree and Shrub Planting List											
			ITEM	QTY.	COMMON NAME	BOTANICAL NAME	SIZE & CONDITION	MATURE HEIGHT				
TREES	SHADE / EVERGREEN / DECIDUOUS	\bigcirc	SHL	4	SUNBURST HONEY LOCUST	GLEDITSIA TRIACANTHOS 'SUNBURST'	2.5" CAL.	30' - 35'				
			SBM	4	SWEETBAY MAGNOLIA	MAGNOLIA VIRGINANA	2.5" CAL.	10' - 20'				
		AMUR.	TJ	3	TAYLOR JUNIPER	JUNIPERUS VIRGINIANA "TAYLOR"	6' - 8' TALL	25 '- 30'				
SHRUBS		+	СВ	19	COMMON BOXWOOD	BUXUS SEMPERVIRENS	3-5 GALLON	24" - 30"				
		Land Standard Standar	GFS	17	GOLDFLAME SPIREA	SPIRAEA X BUMALDA	3-5 GALLON	24" - 30"				
			DBB	21	DWARF BURNING BUSH	EUONYMUS ALATA 'COMPACTA'	3-5 GALLON	48" - 60"				
	GRASS	*	ТН	57	TUFTED HAIRGRASS	DESCHAMPSIA CESPITOSA	1 GALLON	18" - 36"				
GROUND	ÆR		CJ	238 s.f.	GOLDEN CREEPING JENNY	LYSIMACHIA NUMMULARIA 'AUREA'		4" - 6"				
	00		1"- 3" WASHED RIVER ROCK									

General Landscaping Notes

- Landscaping shall be coordinated with the location of utilities, driveways and traffic clearance zones.
 The contractor doing excavation on public right of way shall give 48 hours advance notice to and obtain information from utility companies.
- The contractor doing excavation on public right-of-way shall give 48 hours advance notice to and obtain information from utility companies.
 Prior to commencement of work, the contractor shall notify all those companies which have facilities in the near vicinity of the construction to be performed.
- Existing underground, overhead, utilities and drainage structures have been plotted from available information and therefore, their locations must be considered approximate only. It is the responsibility of the individual contractors to notify the utility companies to locate their utilities before actual construction.
 Contractor shall verify location of and protect all utilities and structures. Damage to utilities and structures shall be repaired by the contractor to the
- satisfaction of the owner at no additional expense.
- Entire site to be irrigated by underground system, including right of way as req'd. (limits of sod including all other disturbed area's and all planting beds)
 Irrigation system shall include an automatic rain sensor.
- All landscape materials shall be installed in accordance with the current planting procedures established by the most recent addition of the American Standard for Nursery Stock.
- Trees planted per this plan shall be installed during the spring (march 15 through june 15) or fall (september 15 through december 1). Written city approval will be required for planting during other times of the year.
- Stake and guy all trees per planting details.
- Install all shrubs and groundcover per planting details.

 | Clausting of tage of models had been all the delivery and discovering the delivery and d
- Elevation of top of mulch shall be 1/2" below any adjacent pavement/turf areas.
 Root stimulator shall be applied to the soil backfill of each plant during installation.
- Contractor shall verify all landscape material quantities and shall report any discrepancies immediately to the Landscape Architect.
- Contractor shall stake plant locations in the field and have approval by the Landscape Architect before proceeding with installation.
 Contractor shall guarantee all plant material for a period of one (1) year from date of initial acceptance. Contractor is responsible for maintaining plant
- contractor shall guarantee air plant material for a period of one (1) year from date of mittal acceptance. Contractor is responsible for maintaining properties and include watering, maintaining plants in vertical position and shrub bed weed control.
 All plant material shall meet or exceed minimum requirements defined by the "American Standard for Nursery Stock" ANSI Z60.1.
- All plant material shall meet or exceed minimum requirements defined by the "American Standard for Nursery Stock" ANSI 260
 No plant material shall be substituted without written approval of the Landscape Architect per specifications.
- Trees and seasonal color areas shall be mulched with three (3) inches minimum shredded hardwood mulch. Planting beds as delineated shall be separated from pavement/turf areas with metal edging and mulched with three (3) inches minimum shredded hardwood mulch over weed barrier fabric,
- except where otherwise specified.
 All existing plant material to be retained shall be wrapped with orange, or bright, colored plastic snow fence around base of trees and around all shrubs.
 Stake to hold in place during construction.
- Stake to hold in place during construction.
 All shrubs used as parking buffer to be min. 18" tall at planting and maintained 3'-0" max. height. Install plants not to encroach upon cars parked, when at full growth
- All trees with above a 2" caliper shall be double staked, while smaller trees shall be single staked.
- Ground mechanical and electrical equipment shall be wholly screened from street right-of-way and residential developments.
- Maximum slope shall be not greater than 3:1.
 All portions of site not covered by paving, mulch, plantings, etc. are to be sodded. Sod shall extend to all disturbed areas and shall include portions of right of way if necessary. Maintain positive drainage.
- Slightly mound all islands at ½" per 12" run.
 Set shrubs a minimum of 3 feet from other site structures walls, walks or curbs.
- Any stiff branched, fruiting or plants with thorns that can damage vehicles are strictly prohibited.
- Utilize washed river rock cover at all planted areas adjacent to building perimeter and hardwood mulch in planting beds throughout remainder of site,

Landscaping Calculations

at Traes


- Private Street Frontage - 1 canopy tree per 40 l.f. @ 141 l.f. = 4 street trees required, 4 provided

Parking Lot Perimeter:


- A continuous non-paved area at least ten feet in width must be located between the pedge of the parking lot and the lot line. 10' minimum provided.

Landscaped Open Space:


- BP/PUD - At least 40% of the total lot area must be landscaped open space. Total lot area = 66,032(.40) = 26,413 sq.ft. landscaped open space. 26,439± sq. ft. provided.

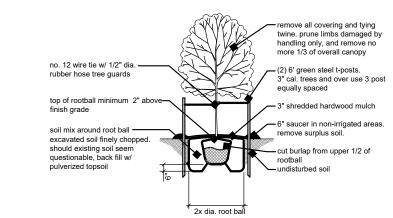


deciduous tree planting deta

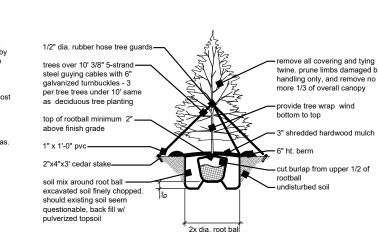

evergreen tree planting detain not to scale

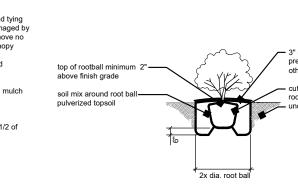

2 | shrub planting detail

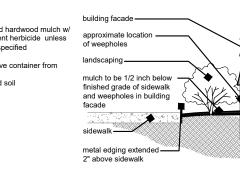

detail | edging | not to scale

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07.14.2022
drawn by
DAE
checked by
DAE
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